## DEMOLITION OF EXISTING STRUCTURES AND CONSTRUCTION OF A SHOPTOP HOUSING AT 352 KING GEORGES RD, BEVERLY HILLS 2209

## **BASIX**<sup>°</sup>Certificate stainability Index www.basi>

Single Dwelling Certificate number: 1256262S\_03 certificate confirms that the p commitments requirements for sus commitments set out below. Terms have the meaning given by the doc 10/09/2020 published by the Depart

Secretary Date of issue: Monday, 14 November 2022 To be valid, this certificate must be lodged v

NSW Planning, Industry & Environmen

u	Project name	352 King Georges F	d, Beverly Hills_03		
	Street address	352 King Georges F	toad Beverly Hills 2209		
	Local Government Area Canterbury-Bankstown Council				
	Plan type and plan number deposited DP 13622				
	Lot no. 1				
	Section no				
meet the NSW	Project type	separate dwelling house			
cordance with the in the commitments,	No. of bedrooms 4				
efinitions" dated	Project score				
	Water	✓ 43	Target 40		
	Thermal Comfort	V Pass	Target Pass		
ate of issue.	Energy	✓ 50	Target 50		

Project su

Project address		Assessor details and thermal l		
Project name	352 King Georges Rd, Beverly Hills_03	Assessor number	n/a	
Street address	352 King Georges Road Beverly Hills 2209	Certificate number	n/a	
Local Government Area	Canterbury-Bankstown Council	Climate zone	n/a	
Plan type and plan number	Deposited Plan DP 13622	Area adjusted cooling load (MJ/m <sup>2</sup> .year)	n/a	
Lot no.	1	Area adjusted heating load (MJ/m <sup>2</sup> .year)	n/a	
Section no.	-	Ceiling fan in at least one bedroom	n/a	
Project type		Ceiling fan in at least one living room or other conditioned area	n/a	
Project type	separate dwelling house	Project score		
No. of bedrooms	4			
Site details		Water	43	Target 40
Site area (m²)	164	Thermal Comfort	V Pass	Target Pass
Roof area (m²)	93		•	. a gott abo
Conditioned floor area (m2)	180.4	Energy	✓ 50	Target 50
Unconditioned floor area (m2)	41.7			
Total area of garden and lawn (m2)	0			

	et out below regulate how the proposed development is to be carried out. It is a condition of any develo sate issued, for the proposed development, that BASIX commitments be complied with.
Water Commitn	ients
Fixtures	
The applicant must i all showers in the de	nstall showerheads with a minimum rating of 4 star (> 4.5 but <= 6 L/min plus spray force and/or coverage tests) in velopment.
The applicant must i	nstall a toilet flushing system with a minimum rating of 4 star in each toilet in the development.
The applicant must i	nstall taps with a minimum rating of 4 star in the kitchen in the development.
The applicant must i	nstall basin taps with a minimum rating of 4 star in each bathroom in the development.
Alternative wate	er
Rainwater tank	
The applicant must i accordance with, the	nstall a rainwater tank of at least 5000 litres on the site. This rainwater tank must meet, and be installed in requirements of all applicable regulatory authorities.
	configure the rainwater tank to collect rain runoff from at least 86 square metres of the roof area of the developmen of the roof which drains to any stormwater tank or private dam).
The applicant must o	connect the rainwater tank to:
	oor tap in the development (Note: NSW Health does not recommend that rainwater be used for human areas with potable water supply.)

Certificate Prepared by			
Name / Company Name: EPW Designs			
ABN (if applicable): 33258955413			





Thermal Comfort Commitments	Show on DA plans	plans & specs	check	
General features				
The dwelling must not have more than 2 storeys.	~	~	~	
The conditioned floor area of the dwelling must not exceed 30	~	~	~	
The dwelling must not contain open mezzanine area exceeding	~	~	~	
The dwelling must not contain third level habitable attic room.		~	~	~
Floor, walls and ceiling/roof				
The applicant must construct the floor(s), walls, and ceiling/ro- below.	of of the dwelling in accordance with the specifications listed in th	e table	~	~
Construction	Additional insulation required (R-Value)	Other specifications		
floor - concrete slab on ground, 157 square metres	nil			
floor - above habitable rooms or mezzanine, 65.1 square metres, concrete	nil			
floor - suspended floor above garage, concrete	nil			
external wall - concrete panel/plasterboard (concrete: 150 mm)	2.09 (or 2.40 including construction)			
ceiling and roof - flat ceiling / flat roof, concrete/plasterboard internal	ceiling: 2.82 (up), roof: none	concrete/plasterboard 0.475)	internal; light (solar abse	orptance <
	ed in accordance with Part 3.12.1.1 of the Building Code of Aust			
Note • In some climate zones, insulation should be installed	d with due consideration of condensation and associated interact	ion with adjoining build	ing materials,	

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Certificate No : 12582828\_03

Monday 14

	nmitments				Show on DA plans	Show on CC/CDC plans & specs	Certifier check
Windows, glazed doc	ors and skyligh	ts					
The applicant must install the specifications listed in the tag	ie windows, glazed able. Relevant overs	doors and shadin shadowing specifi	g devices described in the table belo cations must be satisfied for each wi	ow, in accordance with th indow and glazed door.	• 🗸	~	~
The dwelling may have 1 sk	ylight (<0.7 square	metres) which is r	not listed in the table.		~	~	~
The following requirements	must also be satisfi	ed in relation to e	ach window and glazed door:				
For the following glass a	ind frame types, the	certifier check ca	an be performed by visual inspection	L.			-
- Aluminium single cle							
- Aluminium double (a							
- Timber/uPVC/fibregl	ass single clear						
- Timber/uPVC/fibreglass	double (air) clear						
skylight area must not exce		(the 3 square me	ow, in accordance with the specifica tre limit does not include the optiona				~
U.7 square metres that does	s not have to be list	ed in the table).					
	Maximum area metres)		уре		Shading device		
0.7 square metres that does Skylight no. S01	Maximum area	ı (square T	'ype Iuminium, moulded plastic single cle	ar	Shading device		
Skylight no.	Maximum area metres)	ı (square T		ar			
Skylight no. S01	Maximum area metres)	ı (square T	luminium, moulded plastic single cle			Overshadowing	
Skylight no.	Maximum area metres) 1.08 Maximum	ı (square T a	luminium, moulded plastic single cle	Shading Devic	no shading	Overshadowing	
Skylight no. S01 Window/glazed door no.	Maximum area metres) 1.08 Maximum	ı (square T a	luminium, moulded plastic single cle	Shading Devic 10%) solid overhang	no shading	Overshadowing not overshadowed	

ASIX	Planning, Industry & Environment	www.basb.nsw.gov.au	Version: 3.0 / DARWINIA_3_20_0	Certificate No.: 12562628_03	Monday, 14 November 2022

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aluminium, single, clea

2100

Energy Commitments	Show on DA plans	Show on CC/CDC plans & specs	Certifier check
Hot water			
The applicant must install the following hot water system in the development, or a system with a higher energy rating: gas instantaneous with a performance of 6 stars.	~	~	~
Cooling system			
The applicant must install the following cooling system, or a system with a higher energy rating, in at least 1 living area: 1-phase airconditioning; Energy rating: 6 Star (old label)		~	~
The applicant must install the following cooling system, or a system with a higher energy rating, in at least 1 bedroom: 1-phase airconditioning; Energy rating: 6 Star (old label)		<ul> <li>Image: A set of the set of the</li></ul>	~
The cooling system must provide for day/night zoning between living areas and bedrooms.		¥	~
Heating system			
The applicant must install the following heating system, or a system with a higher energy rating, in at least 1 living area: 1-phase airconditioning; Energy rating: 6 Star (old label)		~	~
The applicant must install the following heating system, or a system with a higher energy rating, in at least 1 bedroom: 1-phase airconditioning; Energy rating: 6 Star (old label)		~	~
The heating system must provide for day/night zoning between living areas and bedrooms.		<ul> <li></li> </ul>	~
Ventilation			
The applicant must install the following exhaust systems in the development:			
At least 1 Bathroom: individual fan, ducted to façade or roof; Operation control: manual switch on/off		<ul> <li>Image: A set of the set of the</li></ul>	~
Kitchen: individual fan, ducted to façade or roof; Operation control: manual switch on/off		~	~
Laundry: individual fan, ducted to façade or roof; Operation control: manual switch on/off		~	~
Artificial lighting			
The applicant must ensure that the "primary type of artificial lighting" is fluorescent or light emitting diode (LED) lighting in each of the following rooms, and where the word "dedicated" appears, the fittings for those lights must only be capable of accepting fluorescent or light emitting diode (LED) lamps:			
<ul> <li>at least 4 of the bedrooms / study;</li> </ul>		~	~

<ul> <li>at least 2 of the living / dining rooms;</li> </ul>		~	
Natural lighting			
The applicant must install a window and/or skylight in the kitchen of the dwelling for natural lighting.	~	~	
Other			
The applicant must install a gas cooktop & gas oven in the kitchen of the dwelling.		~	
The applicant must construct each refrigerator space in the development so that it is "well ventilated", as defined in the BASIX definitions.		<b>v</b>	
The applicant must install a fixed outdoor clothes drying line as part of the development.		~	

Leg	end				
In the	ese commitments, "applicant" me	ans the person carrying o	ut the development.		
Com	mitments identified with a 🧹 in th	ne "Show on DA plans" co	lumn must be shown on the plans ac	companying the development app	lication for th
deve	lopment application is to be lodge	ad for the proposed develo	opment).		
Com	mitments identified with a 🏑 in th	ne "Show on CC/CDC plan	ns and specs" column must be shown	in the plans and specifications a	ccompanying
certif	icate / complying development ce	ertificate for the proposed of	development.		
Com	mitments identified with a 🧹 in th	ne "Certifier check" colum	n must be certified by a certifying auth	ority as having been fulfilled, bef	ore a final occ
final)	for the development may be issu	ied.			
iiX	Planning, Industry & Environment	www.basix.nsw.gov.au	Version: 3.0 / DARWINIA_3_20_0	Certificate No.: 1256262S_03	Monday, 14

## **GENERAL NOTES**

- ALL DIMENSIONS ARE TO BE CHECKED ON SITE PRIOR TO ANY WORK COMMENCEMENT.
- ALL DIMENSIONS ARE IN MILLIMETRES.
- WRITTEN DIMENSIONS WILL TAKE PRECEDENCE OVER SCALE
- GROUND LEVELS ARE APPROXIMATE ONLY. ALL TIMBER FRAME WORKS SHALL BE IN
- ACCORDANCE WITH TIMBER FRAME CODE.

REVISION	AMENDMENTS	Date	
	Amendment to Council	23/1/22	
	Revision 2	2/2/22	
	Front facade	23/2/2022	
	Revision 3	13/2/25	
	Issue for S4.55	23/05/25	

EPW	109 WOOLCOTT ST. EARLWOOD NSW 2206
P M E	(02) 9591 5292 0402206326 epwdesigns@gmail.com

## DRAWING TITLE: BASIX COMMITMENTS

DRAWING TITLE:	PLOT DATE:	22/05/2025 4:59:53 PM	
BASIX COMMITMENTS	SCALE:	(A3)	
DEMOLITION OF EXISTING STRUCTURES AND CONSTRUCTION OF A SHOPTOP HOUSING	SCALL.	(43)	
		LAL	
AT: NO. 352 KING GEORGES RD, BEVERLY HILLS 2209	DRAWN BY:	LN	
SECTION 4.55 (1a) MODIFICATION	SHEET:	S4.55 00	

cation for the proposed development (if a			
companying the application for a construction			
e a final occupation certificate(either interim or			
Monday, 14 November 2022	page 9/9		
monoly, in monomous adde	halle and		
			DATE

fonday, 14 November 2022	pag

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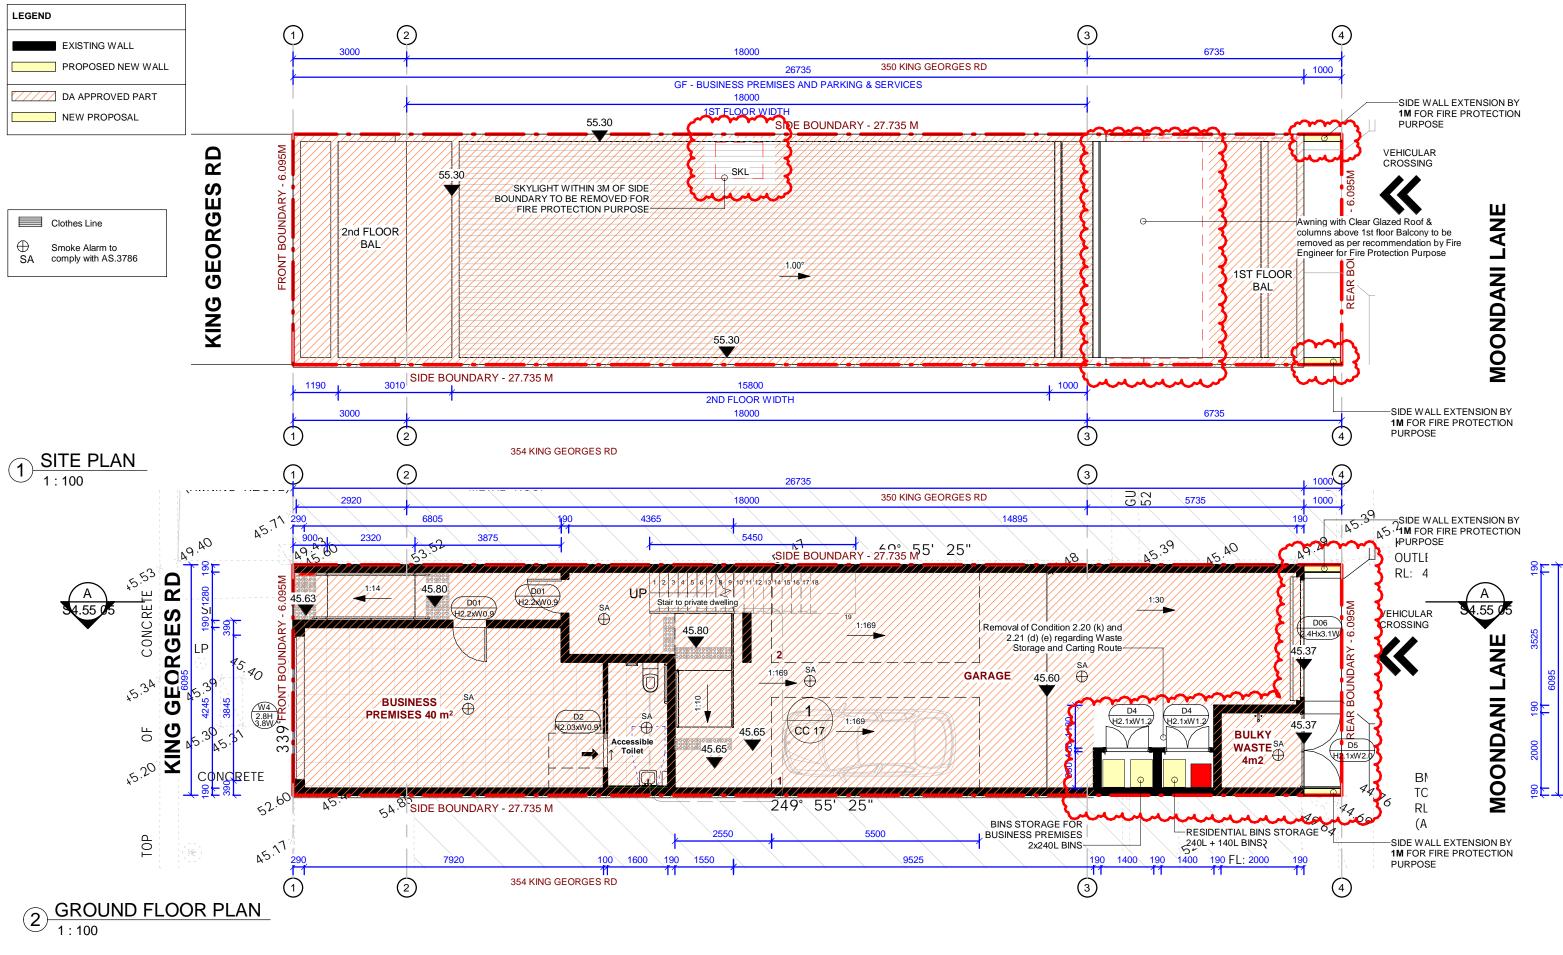
Shading Device ( 10%) base of window

verandah 3000 mm, 300 m base of window or glazed

solid overhang 1000 mm, above head of window or solid overhang 2000 mm, 3 above head of window or g solid overhang 2000 mm, 3 above head of window or g door solid overhang 1000 mm, 3 above head of window or g door

none none

iow on A plans	Show on CC/CDC plans & specs	Certifier check
	~	~
	~	~
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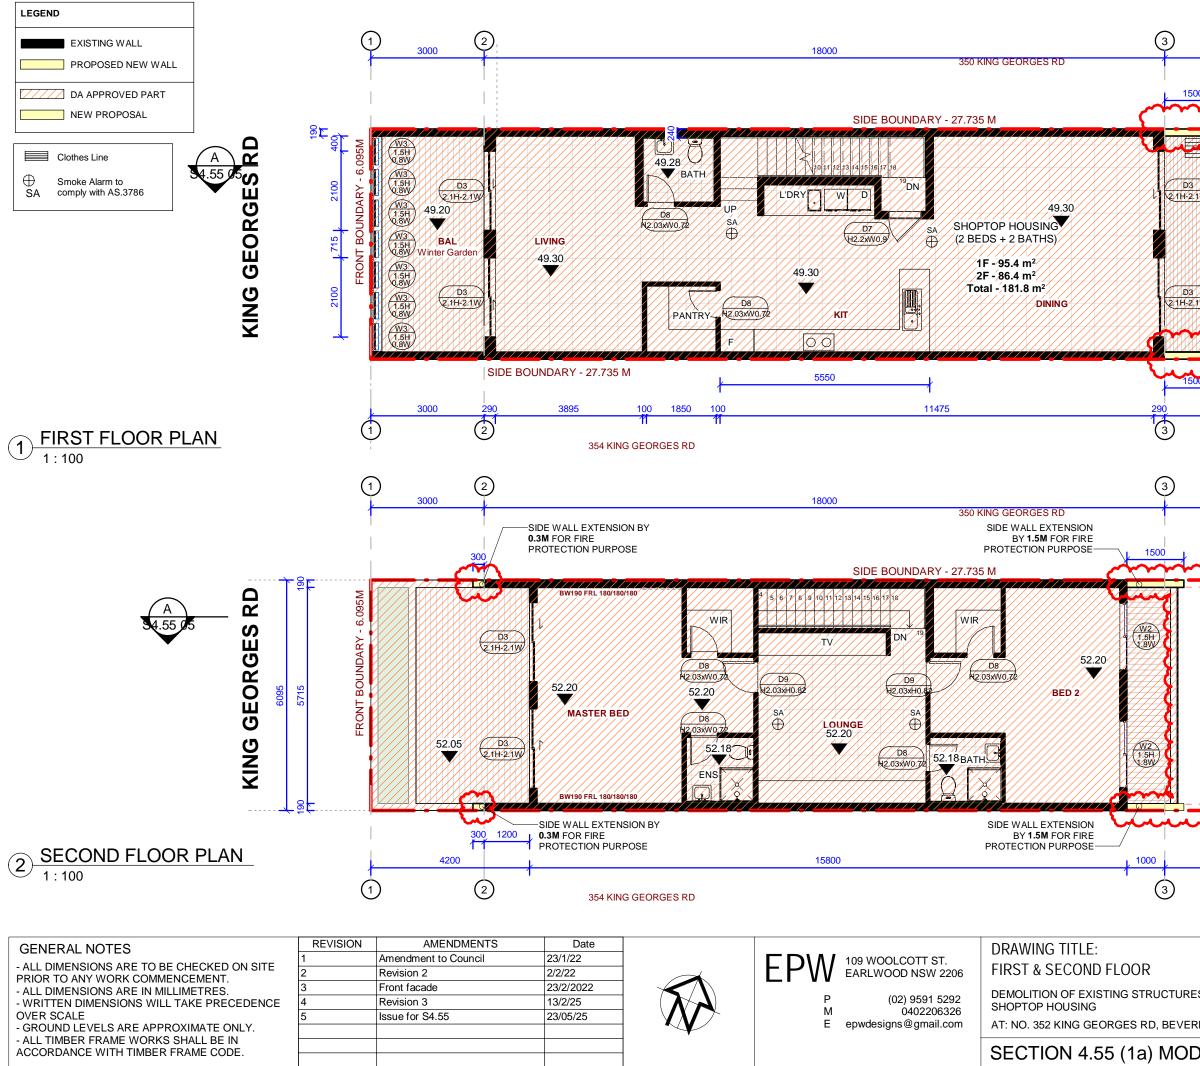
GENERAL NOTES	REVISION	AMENDMENTS	Date			
	1	Amendment to Council	23/1/22	]		109 WC
- ALL DIMENSIONS ARE TO BE CHECKED ON SITE PRIOR TO ANY WORK COMMENCEMENT.	2	Revision 2	2/2/22			EARLW
- ALL DIMENSIONS ARE IN MILLIMETRES.	3	Front facade	23/2/2022			
- WRITTEN DIMENSIONS WILL TAKE PRECEDENCE	4	Revision 3	13/2/25	1 ( <b>)</b>	P	
OVER SCALE	5	Issue for S4.55	23/05/25		M	
- GROUND LEVELS ARE APPROXIMATE ONLY.					E	epwdes

- ALL TIMBER FRAME WORKS SHALL BE IN
ACCORDANCE WITH TIMBER FRAME CODE.

Revision 2	2/2/22
Front facade	23/2/2022
Revision 3	13/2/25
Issue for S4.55	23/05/25

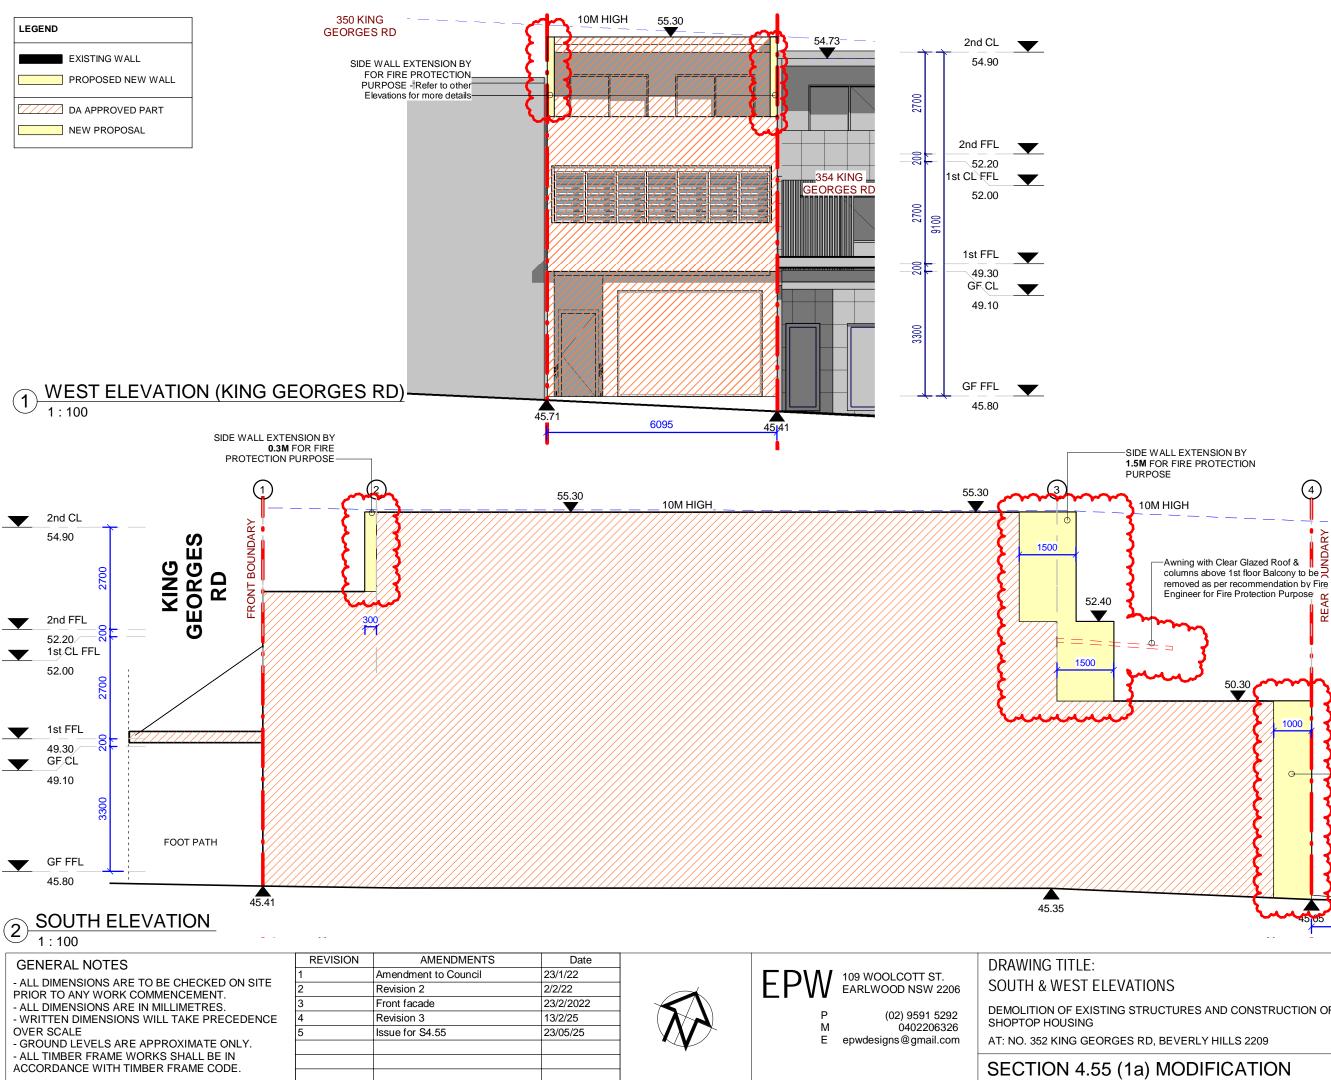
		SECTION 4.55 (1a) MOI
E	epwdesigns@gmail.com	AT: NO. 352 KING GEORGES RD, BEVE
P M	(02) 9591 5292 0402206326	DEMOLITION OF EXISTING STRUCTURI SHOPTOP HOUSING
EPW	109 WOOLCOTT ST. EARLWOOD NSW 2206	DRAWING TITLE: SITE PLAN & GROUND FLOOR

	PLOT DATE:	22/05/2025 4:59:54 PM
RES AND CONSTRUCTION OF A	SCALE: As i	ndicated (A3)
ERLY HILLS 2209	DRAWN BY:	LN
DIFICATION	SHEET:	S4.55 01



SIDE WALL EXTENSION BY 1.5M FOR FIRE PROTECTION PURPOSE 6735 SIDE SCREEN WITH OF 1.8M TO BE REMON FOR FIRE PROTECT PURPOSE	ON 4 HEIGHT OVED
BAL 03 12.11₩ BAL 03 1.2.11₩	REAR BOUNDARY - 6.095M 6095 MOONDANI LANE
SIDE WALL EXTENSION BY 1500 I.5M FOR FIRE PROTECTION PURPOSE 4595 I140	
6735	r to be n by Fire
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ES AND CONSTRUCTION OF A			
RLY HILLS 2209	DRAWN BY:	LN	
DIFICATION	SHEET:	S4.55 02	



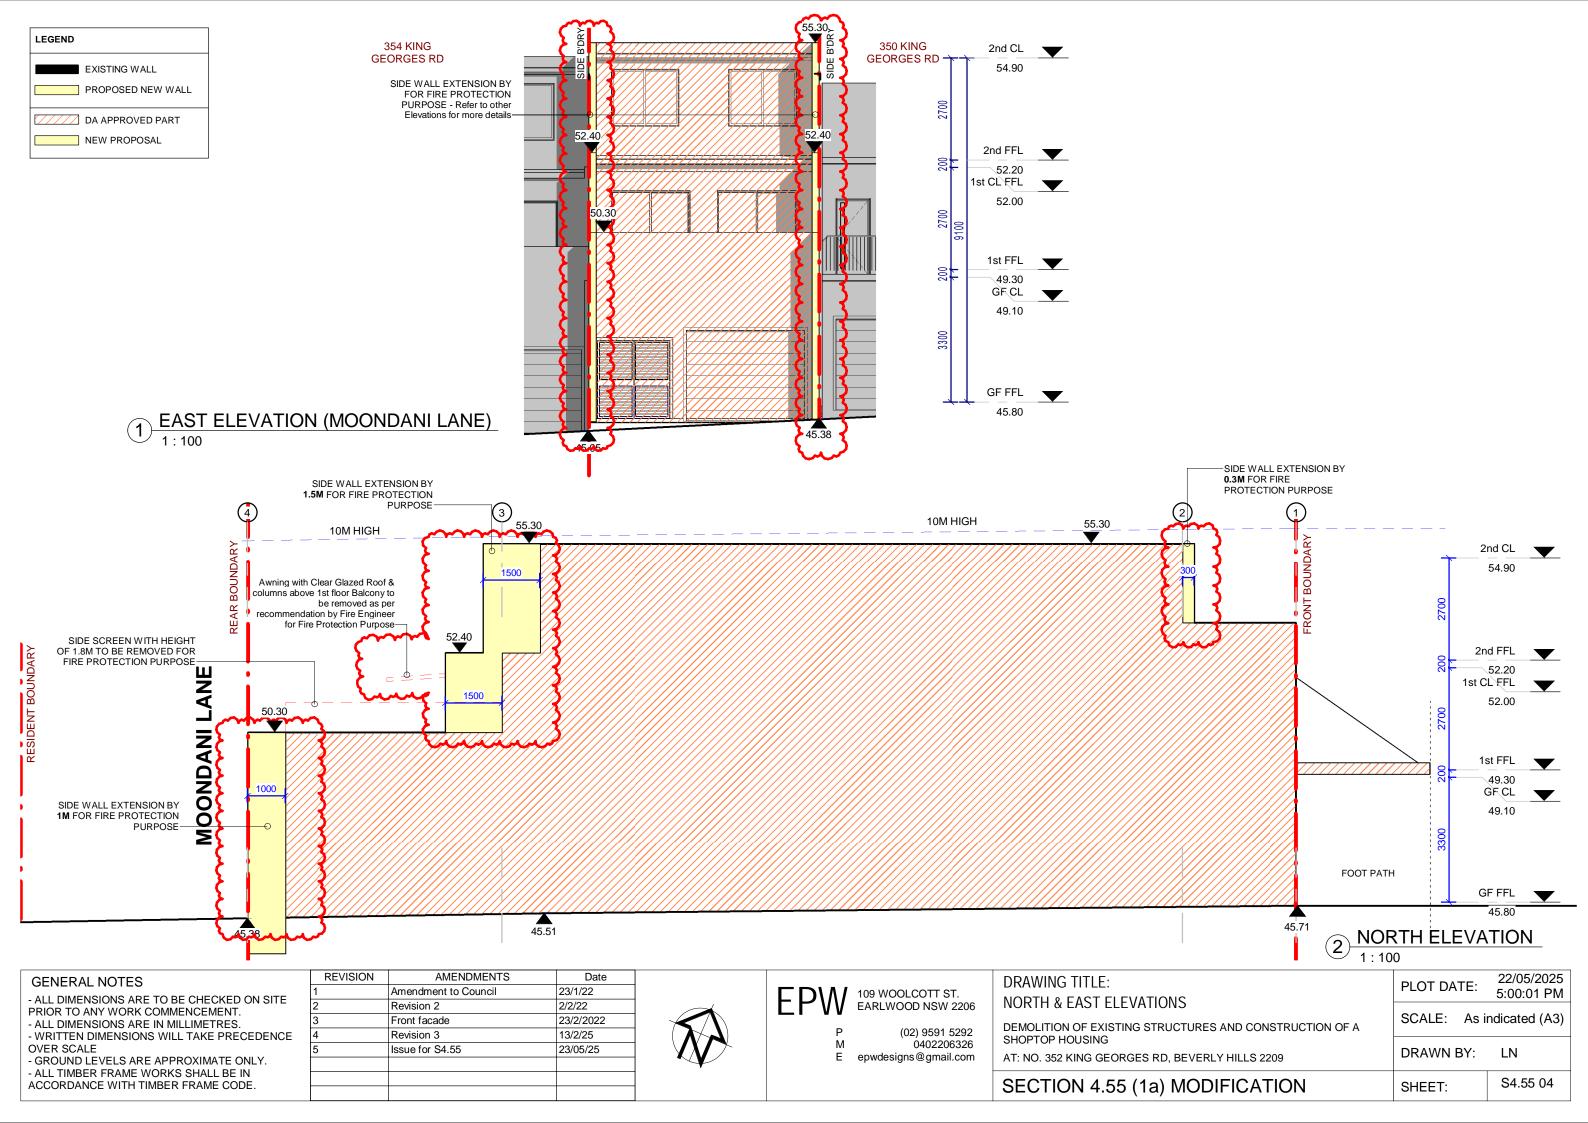
50.30	1M I	E WALL EXTENSION FOR FIRE PROTECTION POSE			
Lungs	05	6000			
	<u></u>	PLOT DATE:	22/05/2025 4:59:59 PM		
RES AND CONSTRUCTIO	N OF A	SCALE: As indicated (A3)			
ERLY HILLS 2209		DRAWN BY:	LN		
DIFICATION		SHEET:	S4.55 03		

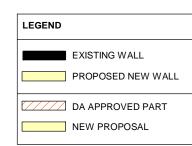
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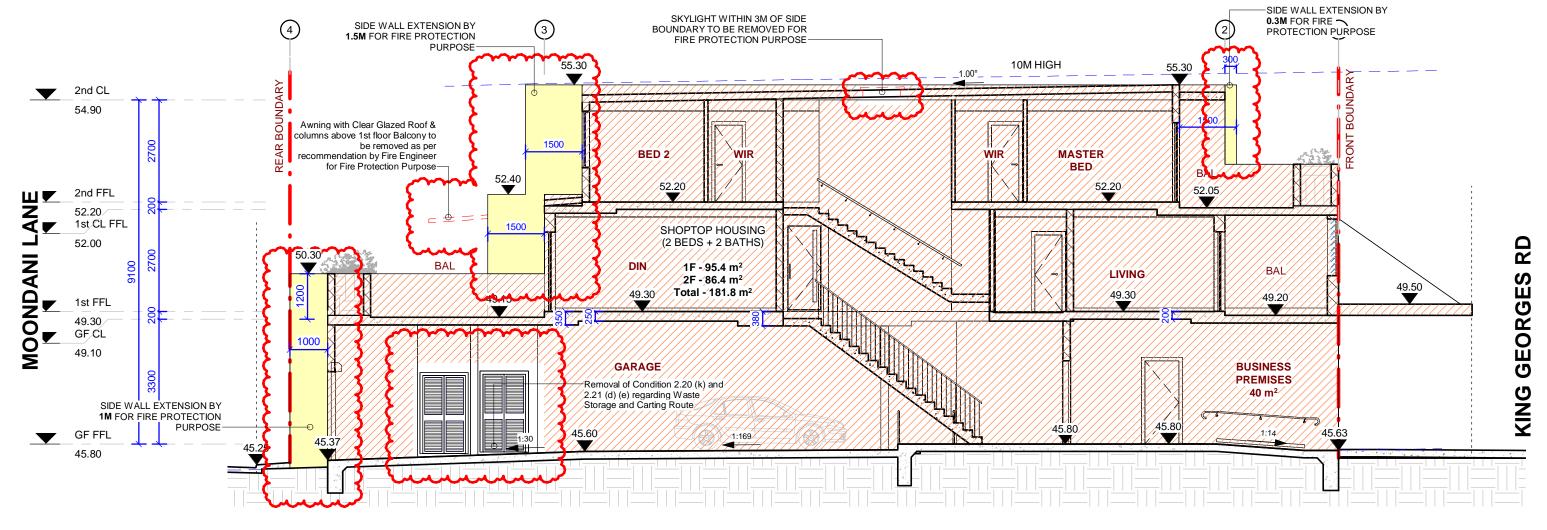
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GENERAL NOTES - ALL DIMENSIONS ARE TO BE CHECKED ON SITE PRIOR TO ANY WORK COMMENCEMENT. - ALL DIMENSIONS ARE IN MILLIMETRES. - WRITTEN DIMENSIONS WILL TAKE PRECEDENCE OVER SCALE - GROUND LEVELS ARE APPROXIMATE ONLY. - ALL TIMBER FRAME WORKS SHALL BE IN	REVISION           1           2           3           4           5	AMENDMENTS Amendment to Council Revision 2 Front facade Revision 3 Issue for S4.55	Date 23/1/22 2/2/22 23/2/2022 13/2/25 23/05/25	EPW 109 WOOLCOTT ST. EARLWOOD NSW 2206 P (02) 9591 5292 M 0402206326 E epwdesigns@gmail.com	DRAWING TITLE: SECTION A-A DEMOLITION OF EXISTING STRUCTURES AND CONSTRUCTION OF A SHOPTOP HOUSING AT: NO. 352 KING GEORGES RD, BEVERLY HILLS 2209	PLOT DATE: SCALE: As i DRAWN BY:	22/05/2025 5:00:02 PM Indicated (A3) LN S4.55 05
ACCORDANCE WITH TIMBER FRAME CODE.					SECTION 4.55 (1a) MODIFICATION	SHEET:	34.55 05